LAHC PAGEWOOD DEVELOPMENT

36-38 BIRDWOOD AVENUE, PAGEWOOD NSW



1. THE DRAWING ISSUED IS DIAGRAMMATIC. DO NOT SCALE. USE FIGURED DIMENSIONS ONLY. REFER TO ARCHITECTURAL DRAWINGS WHERE APPROPRIATE FOR EXACT LOCATION OF FIXTURES, DUCTS AND THE LIKE, THE DRAWING IS TO BE READ IN CONJUNCTION WITH ALL OTHER DOCUMENTS FORMING THE PROJECT

2. CONFIRM ALL LEVELS AND DIMENSIONS AS ACCURATE ON SITE PRIOR TO INSTALLATION. REPORT ALL DISCREPANCIES TO THE SUPERINTENDENT

REPRODUCTION OF THE WHOLE OR PART OF THIS DRAWING WITHOUT THE

EXPRESS PERMISSION OF MCCALLUM PLUMBING & FIRE CONSULTANTS

AUSTRALIA IS A BREACH OF THE COMMONWEALTH COPYRIGHT ACT.

3. THIS DRAWING HAS BEEN ISSUED IN CONFIDENCE AND REMAINS THE PROPERTY OF MCCALLUM PLUMBING & FIRE CONSULTANTS AUSTRALIA DISTRIBUTION OR

DOCUMENTATION PACKAGE

HYDRAULIC SERVICES

NOTE: THE ENTIRE PLUMBING INSTALLATION IS TO COMPLY WITH THE FULL REQUIREMENTS OF THE LOCAL REGULATORY AUTHORITY, A.S.3500 AND THE PLUMBING AND THE BUILDING CODES OF AUSTRALIA.

FAMILIARISE THEMSELVES WITH EXISTING SITE CONDITIONS AND MAKE THE NECESSARY ALLOWANCE FOR SUCH IN THE TENDER

NOTE: THE TENDERER MUST READ THIS DRAWING IN CONJUNCTION WITH THE PROJECT DRAWINGS FROM THE

NOTE: THE NOMINAL SIZES OF PIPELINES NOTED ON THE PIPELINE MATERIAL BEING ACCEPTED BY THE SUPERINTENDENT, IT IS THE PLUMBING CONTRACTORS RESPONSIBILITY TO ENSURE THAT AN EQUIVALENT INTERNAL PIPELINE BORE IS INSTALLED IN ACCORDANCE WITH APPENDIX J OF AS 3500.1

ABBREVIATIONS	ABBREVIATIONS	ABBREVIATIONS	PIPELINES	SYMBOLS	SYMBOLS	SYMBOLS
AV AIR ADMITTANCE VALVE C ACCESS CHAMBER D BALCONY DRAIN C CLEAROUT PBSC CHROME PLATED BRASS SCREWED CLEAROUT W COLD WATER D DOWNPIPE PS DOWNPIPE SPREADER W DISHWASHER C EXISTING	FW FLOOR WASTE H HAND BASIN HT HOSE TAP HW HOT WATER IL INVERT LEVEL IS INSPECTION SHAFT K KITCHEN SINK OF OVERFLOW OG OVERFLOW GULLY RW RAINWATER RWH RAIN WATER HEAD	S SHOWER SS SOIL STACK SW STORMWATER T LAUNDRY TUB UPVC UNPLASTICISED POLYVINYL CHLORIDE VP VENT PIPE W WATER CLOSET WM WASHING MACHINE WS WASTE STACK	COLD WATER - EXISTING COLD WATER - NEW HOT WATER - NEW RW RAIN WATER - NEW SANITARY DRAINAGE - EXISTING S S S SANITARY DRAINAGE - NEW SW STORMWATER DRAINAGE - NEW ELECTRICAL WIRING	FIXTURE CONNECTION PIPEWORK DROPPER LINE CAP WATER SUPPLY RISER RISER SERVICE PIPE SIZE DROPPER ISOLATION VALVE SUB WATER METER	HWU HOT WATER UNIT RC RAINCHANGER SYSTEM PUMP HT HOSE TAP SANITARY RISER CO CLEAROUT CHROME PLATED BRASS SCREWED CLEAROUT FW FLOOR WASTE	OG OVERFLOW GULLY IS INSPECTION SHAFT ACCESS CHAMBER AAV AIR ADMITTANCE VALV DP DOWNPIPE BALCONY DRAIN H STREET HYDRANT STORMWATER RISER

NOTES: SANITARY DRAINAGE

- 1. DRAINS BELOW GROUND UNDER BUILDINGS MAY BE LAID WITH LESS THAN THE MINIMUM COVER OF 450mm PROVIDED THAT 25mm OF OVERLAY SEPARATES THE DRAIN FROM THE REINFORCED CONCRETE SLAB.
- 2. DRAINS PASSING THROUGH WALLS AND FOOTINGS SHALL BE INSTALLED WITH AN ANNULAR SPACE OF NOT LESS
- 3. COORDINATE THE INSTALLATION OF SANITARY SERVICES WITH OTHER SERVICES.
- 4. LOCATE, EXCAVATE AND VERIFY THE SUITABILITY OF THE LEVEL OF THE EXISTING DRAINAGE PIPELINE FOR CONNECTION PRIOR TO THE COMMENCEMENT OF ANY DRAINAGE INSTALLATION WORKS.
- 5. CONTRACTORS ARE TO ALLOW FOR ALL BENDS, OFFSETS, RISERS AND DROPPERS TO ALL OF THE PIPEWORK NECESSARY TO ACHIEVE A FULLY FUNCTIONING, COORDINATED COMPLIANT INSTALLATION.
- 6. ALL INGROUND PIPEWORK IS TO BE ENCASED IN 7-10mm GRAVEL WITH DETECTABLE MARKER TAPE AND SAND
- 7. ALL HAND BASIN WASTES ARE TO BE P-TRAP TYPE WITH DROPPERS CONCEALED WITHIN THE WALL. 8. THE MAIN SEWER CONNECTION POINT AND SHAFT IS TO BE 150mm.
- 9. ALL SANITARY DRAINAGE IS TO BE CONSTRUCTED IN THE MATERIAL NOMINATED ON THE DRAWINGS AND TO THE REQUIREMENTS OF THE RELEVANT CODES AND AUTHORITIES. MINIMUM GRADE SHALL BE OF 1 IN 60 (1.65%) OR
- AS OTHERWISE SPECIFIED. 10. WHERE DRAINAGE LEVELS PERMIT, ALL BRANCH LINES SHALL BE GRADED AND/OR LOWERED TO AVOID PENETRATING FOOTING BEAMS UNLESS SHOWN OTHERWISE. THE CONTRACTOR SHALL ALLOW FOR ADDITIONAL

PIPE LENGTHS AND WORK DURING CONSTRUCTION INCLUDING ADDITIONAL INSPECTION OPENINGS IN THE

- 11. PROVIDE INSPECTION OPENINGS IN THE SYSTEM AS REQUIRED BY A.S3500.2.2 SEC 4.7 OR AS REQUIRED BY THE RELEVANT AUTHORITY
- 12. ALL VENTS ARE TO TERMINATE WITH A VENT COWL AND OVER FLASHING ABOVE THE ROOF LEVEL. ROOF TO BE
- LEFT WATERTIGHT. 13. ALL PIPEWORK TO BE TESTED TO AS 3500 REQUIREMENTS.

MAINTAINED AT THAT LEVEL DURING CONSTRUCTION AND BACKFILLING.

REVISED PRELIMINARY-75%

PRELIMINARY-75%

AMENDMENT

27/02/23

- 14. ALL EXISTING SEWER CONNECTIONS TO BE DISUSED SHALL BE SEALED AT THE CLOSEST POINT TO THE MAIN LINE AND TO THE RELEVANT CODES AND AUTHORITIES REQUIREMENTS.
- 15. ALL VENTS SHALL BE OFFSET IN THE ROOF SPACE A MINIMUM OF 600mm FROM EAVES AND BOX GUTTERS OR AS SHOWN ON DRAWINGS
- 16. FLOORWASTES TO HAVE 'GRATE SEAL' INSTALLED WHERE TUBS ARE CONNECTED TO THEM. 17. ALL EXPOSED FIXTURE CONNECTION PIPELINES WITHIN THE BUILDING CONNECTING TO FIXTURES ARE TO BE
- 18. IN WATER CHARGED GROUND THE WATER LEVEL SHALL BE LOWERED BELOW THE PROPOSED TRENCH AND

NOTES: SANITARY STACK DRAINAGE

- 1. ALL PIPEWORK IS TO BE UPVC DWV GRADE UNLESS NOTED OTHERWISE. 2. COORDINATE THE INSTALLATION OF ALL PIPEWORK WITH OTHER
- SERVICES. 3. PIPEWORK PASSING THROUGH FIRE RATED WALLS, FLOORS, CEILING
- VOIDS AND WHERE NOTED IS TO BE FIRE RATED TO AS4072 OR AS SPECIFIED.
- 4. CONTRACTORS TO ALLOW FOR ALL BENDS, OFFSETS, RISERS AND DROPPERS TO ALL OF THE PIPEWORK NECESSARY TO ACHIEVE A FULLY FUNCTIONING, COORDINATED COMPLIANT INSTALLATION.
- CONCEAL ALL PIPEWORK IN WALLS, CEILING VOIDS, COLUMNS AND DUCTS. 6. ALL PIPEWORK IS TO BE FIXED AT HIGH LEVEL TO THE UNDERSIDE OF THE
- FLOOR STRUCTURE. 7. ALL PIPES RECEIVING DISCHARGE FROM SOIL FIXTURES SHALL BE PROVIDED WITH AN INSPECTION OPENING AND EXPANSION JOINT AT THE
- BASE OF EVERY SANITARY STACK DRAINAGE RISER. ALL PIPEWORK TO BE TESTED TO AS 3500 REQUIREMENTS. 9. ALL EXPOSED PIPELINES WITHIN THE BUILDING CONNECTING TO FIXTURES ARE TO BE CHROME PLATED.

NOTES: STORMWATER DRAINAGE

- 1. ALL STORMWATER DRAINAGE IS TO BE CONSTRUCTED IN THE MATERIAL NOMINATED ON THE DRAWINGS AND TO THE REQUIREMENTS OF THE RELEVANT CODES AND AUTHORITIES HAVING MINIMUM GRADES OF 1 IN 100 (1.00%) OR AS OTHERWISE SPECIFIED.
- 2. CONTRACTORS ARE TO ALLOW FOR ALL BENDS, OFFSETS, RISERS AND DROPPERS TO ALL OF THE PIPEWORK NECESSARY TO ACHIEVE A FULLY FUNCTIONING, COORDINATED COMPLIANT INSTALLATION.

NOTES: COLD WATER

- 1. COORDINATE THE INSTALLATION OF COLD WATER SUPPLY WITH OTHER SERVICES. 2. PIPEWORK PASSING THROUGH CONCRETE SLABS OR PATHS SHALL BE INSTALLED
- WITH AN ANNULAR SPACE OF 6mm FOR THE FULL DEPTH OF SLAB PENETRATION. 3. INGROUND PIPEWORK IS TO BE ENCASED IN CLEAN FILL SAND WITH DETECTABLE MARKER TAPE LAID OVER. 4. CONTRACTORS ARE TO ALLOW FOR ALL BENDS, OFFSETS, RISERS AND DROPPERS
- TO ALL OF THE PIPEWORK NECESSARY TO ACHIEVE A FULLY FUNCTIONING. COORDINATED COMPLIANT INSTALLATION.
- 5. PIPEWORK PASSING THROUGH FIRE RATED WALLS, FLOORS, CEILING VOIDS AND WHERE REQUIRED TO BE FIRE RATED TO AS4072 OR AS SPECIFIED.
- 6. ALL FIXTURES ARE REQUIRED TO HAVE SEPARATE ISOLATION VALVES INSTALLED
- DIRECTLY UNDER UNLESS OTHERWISE SPECIFIED. 7. CONCEAL ALL PIPEWORK IN WALLS, DUCTS AND CEILING VOIDS WHERE PRACTICABLE.
- 8. HOSE TAP TO BE INSTALLED DIRECTLY OVER OVERFLOW GULLY.
- 9. ALL PIPELINES TO BE TESTED TO AS 3500 REQUIREMENTS.

NOTES: RAINWATER


- 1. ALL PIPEWORK TO BE POLYETHYLENE PN12.5 INGROUND OR CROSS LINKED
- POLYETHYLENE (REHAU OR EQUIVALENT) ABOVE GROUND. 2. CONCEAL ALL PIPEWORK IN WALLS AND CEILING VOIDS WHERE PRACTICABLE.
- RAINWATER PIPES ARE TO BE LILAC IN COLOUR IN ALL LOCATIONS. 4. INGROUND PIPEWORK IS TO BE ENCASED IN CLEAN FILL SAND WITH DETECTABLE MARKER TAPE LAID OVER.
- 5. PIPEWORK PASSING THROUGH CONCRETE SLABS OR PATHS SHALL BE INSTALLED
- WITH ANNULAR SPACE OF 6mm FOR THE FULL DEPTH OF SLAB PENETRATION. 6. PIPEWORK PASSING THROUGH FIRE RATED WALLS, FLOORS, CEILING VOIDS TO BE FIRE RATED TO AS4072 OR AS SPECIFIED.
- 7. CONTRACTORS ARE TO ALLOW FOR ALL BENDS, OFFSETS, RISERS AND DROPPERS TO ALL OF THE PIPEWORK NECESSARY TO ACHIEVE A FULLY FUNCTIONING, COORDINATED COMPLIANT INSTALLATION.
- 8. ALL PIPELINES TO BE TESTED TO AS 3500 REQUIREMENTS.


NOTES: HOT/WARM WATER

- 1. ALL HOT AND WARM WATER PIPING IS TO BE INSULATED WITH THERMOTEC SEALED TUBE L/Z (15mm MINIMUM IN ORDER TO COMPLY WITH BCA PART J 7.2) IN WALLS, CEILING AND WHERE EXPOSED UNLESS
- SPECIFIED OTHERWISE 2. CONTRACTORS ARE TO ALLOW FOR ALL BENDS, OFFSETS, RISERS AND DROPPERS TO ALL OF THE PIPEWORK NECESSARY TO ACHIEVE FULLY FUNCTIONING COORDINATED COMPLIANT INSTALLATION.
- 3. COORDINATE THE INSTALLATION OF HOT/WARM WATER SUPPLY WITH OTHER SERVICES. CONCEAL ALL PIPEWORK IN WALLS, DUCTS AND CEILING VOIDS WHERE PRACTICABLE.
- 5. ALL FIXTURES ARE TO HAVE SEPARATE ISOLATING VALVES INSTALLED DIRECTLY UNDER UNLESS
- OTHERWISE SPECIFIED.
- 6. PIPEWORK PASSING THROUGH FIRE RATED WALLS, FLOORS, CEILING VOIDS AND WHERE REQUIRED IS TO BE FIRE RATED TO AS4072 OR AS SPECIFIED.
- 7. ALL PIPELINES TO BE TESTED TO AS 3500 REQUIREMENTS.



633	ARCHITEC	T: CKDS ARCHITECTURE	Drawn N.CHHETRI	PRELIMIN	IARY-75%	Size A1
	CLIENT:	CKDS ARCHITECTURE	Design B.McCALLUM	Scale N.T.S.	Job No. 4713-1121D	No. in Set
RS IA	PROJECT:	LAHC PAGEWOOD DEVELOPMENT 36-38 BIRDWOOD AVENUE, PAGEWOOD NSW TITLE, LEGEND AND NOTES SHEET	I V.IVIOO/ NEEOIVI	DRG. No.	01	Revision 2

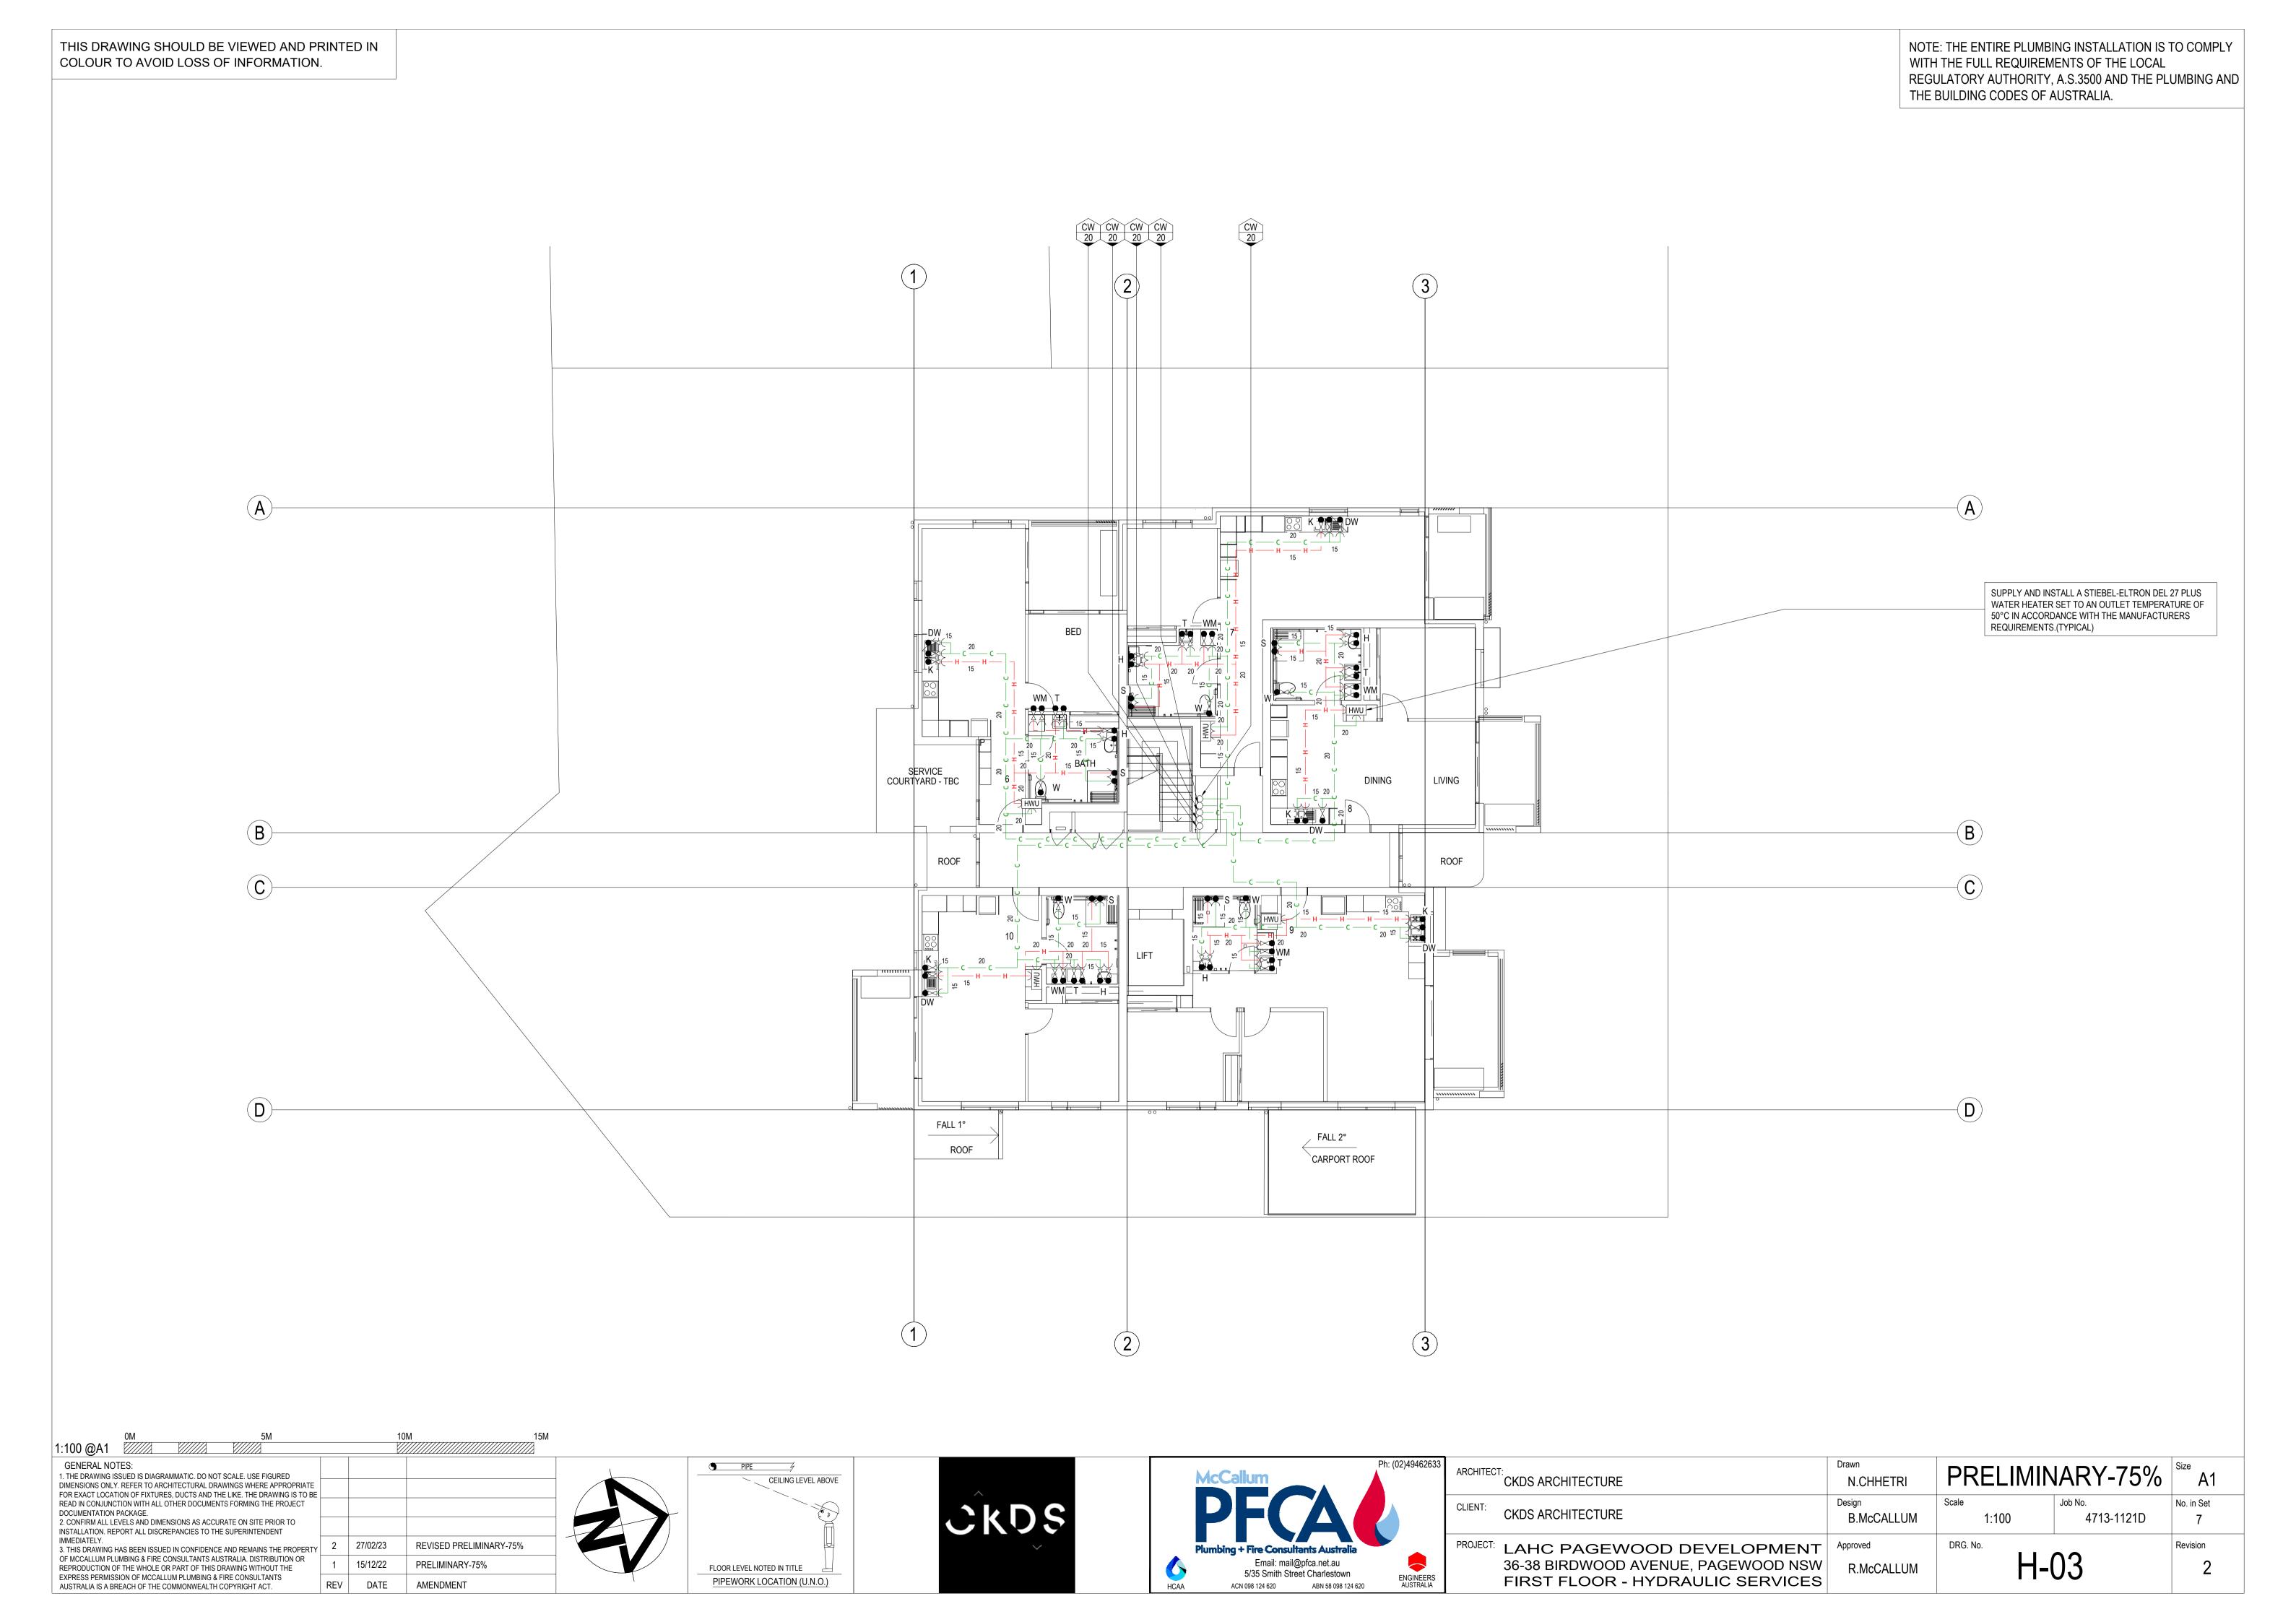

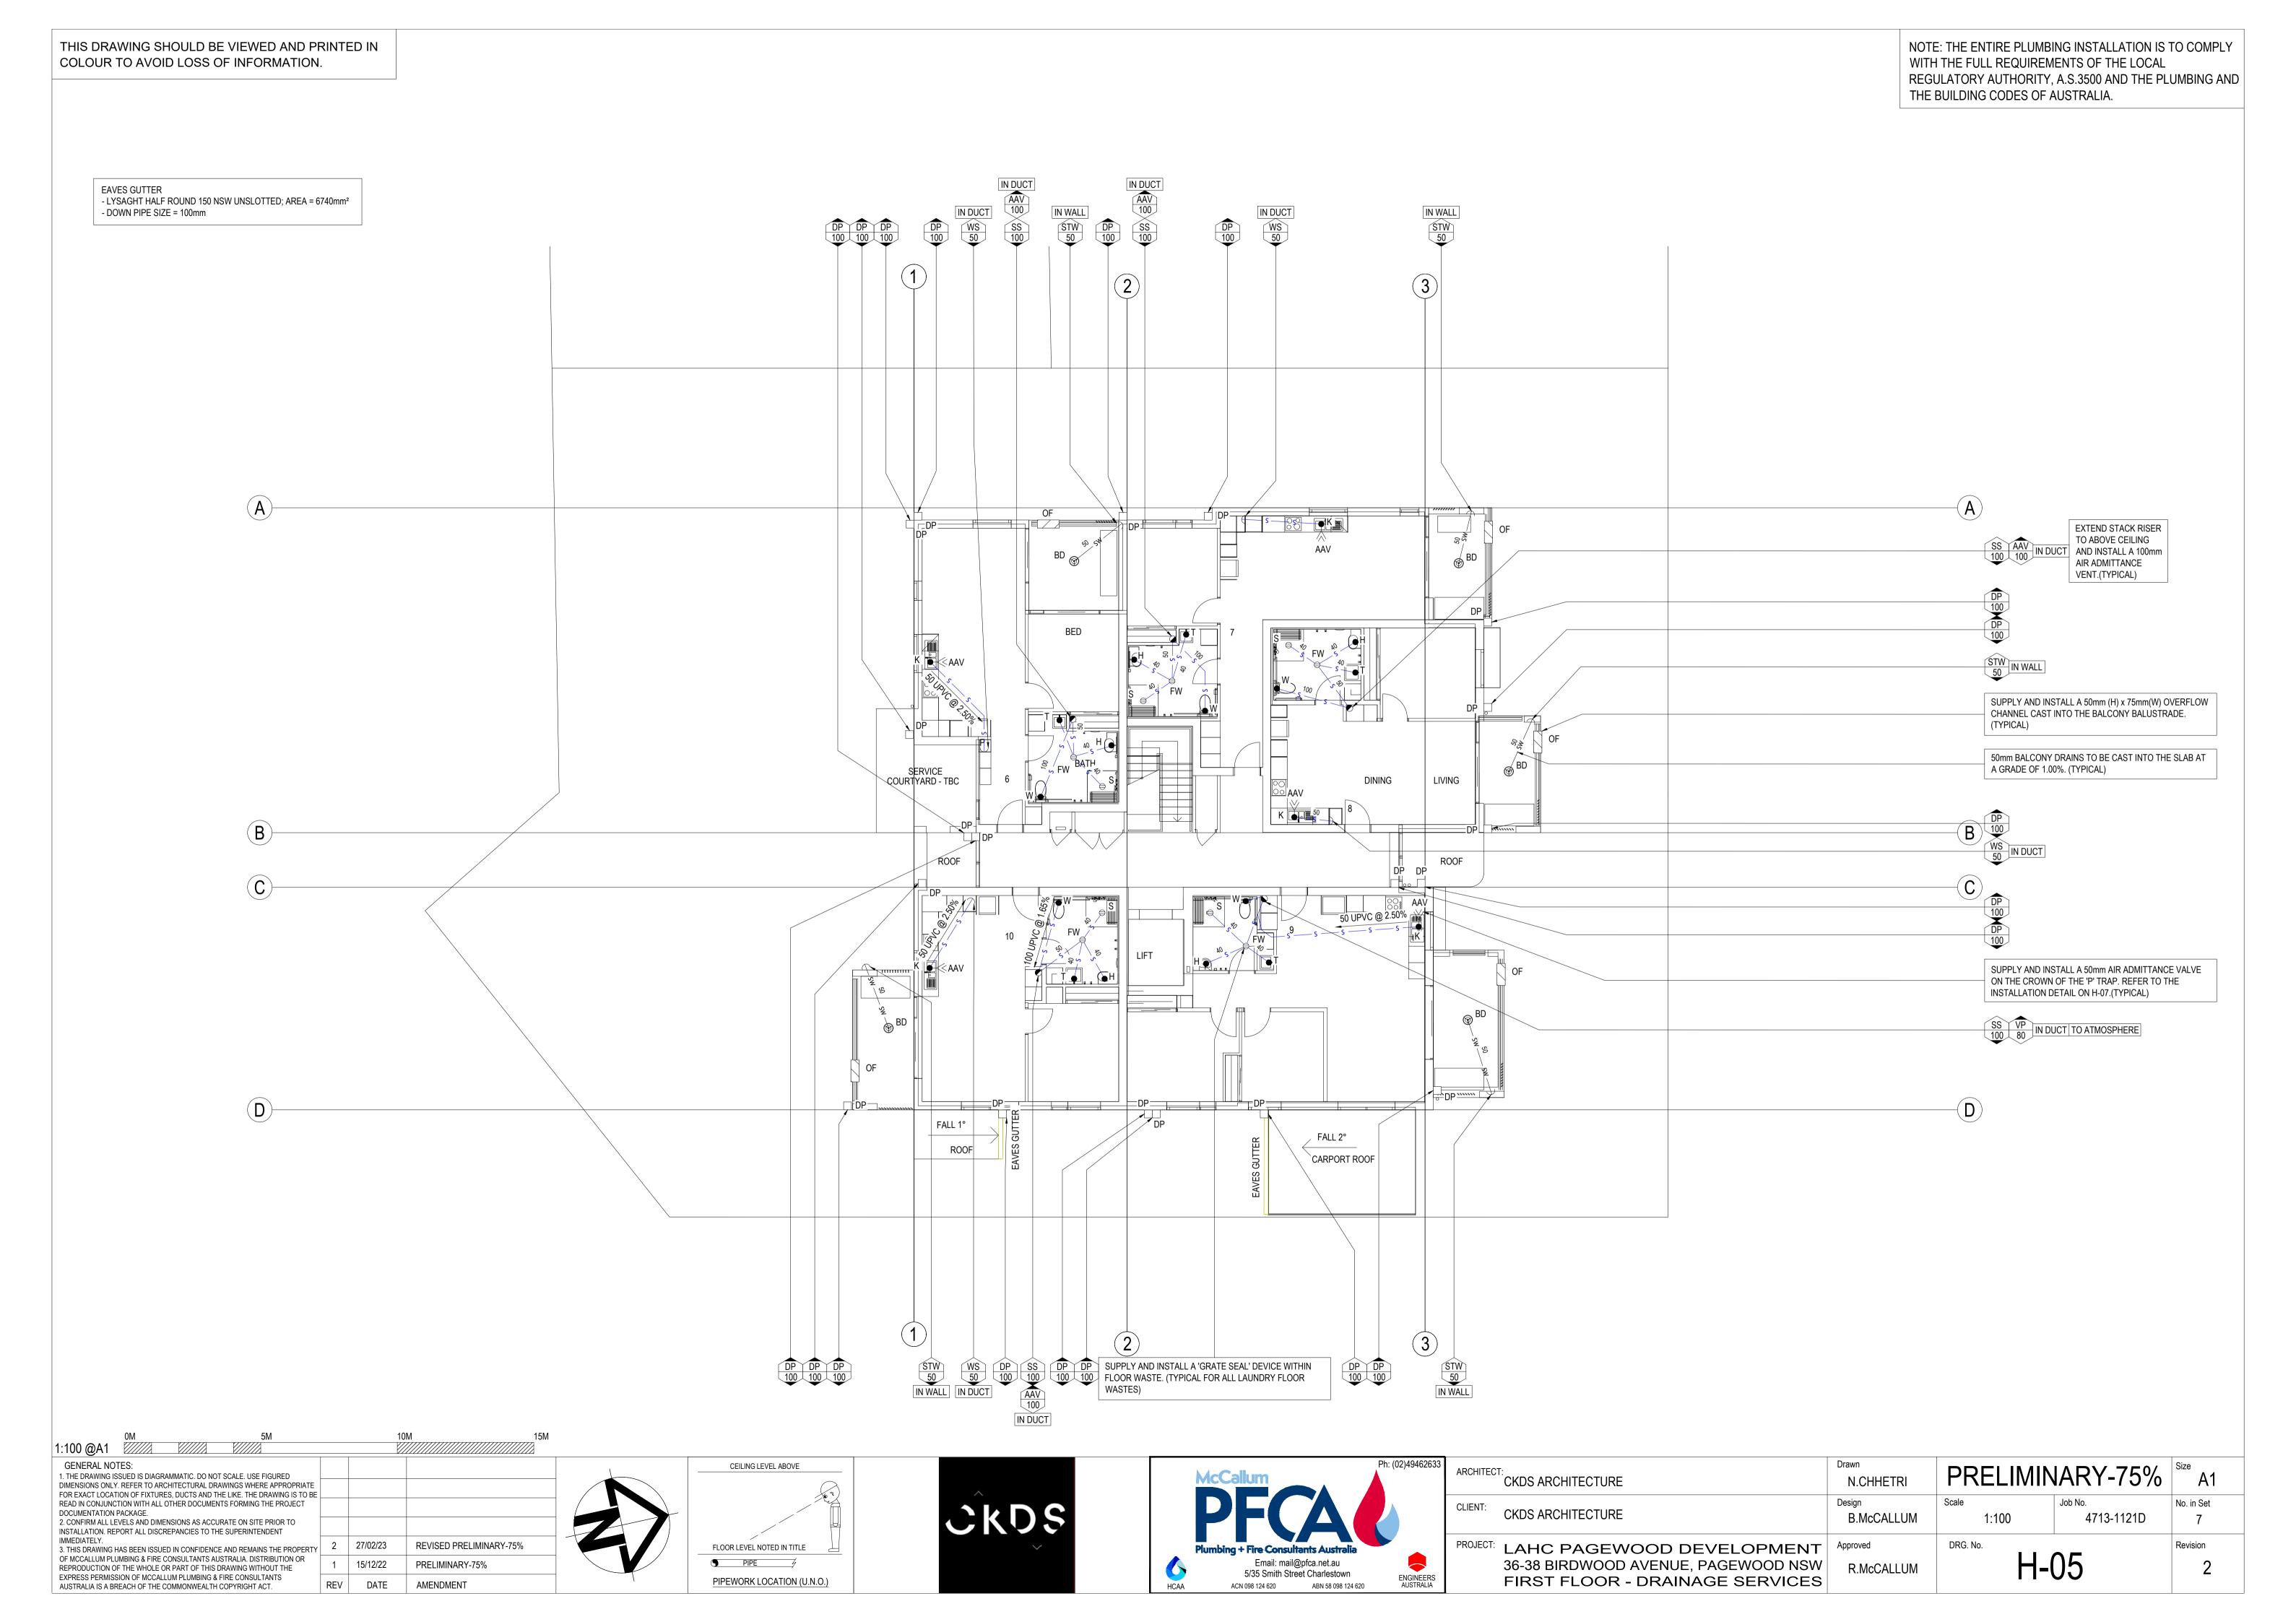

EAVES GUTTER
- LYSAGHT HALF ROUND 150 NSW UNSLOTTED; AREA = 6740mm²
- DOWN PIPE SIZE = 100mm

BOX GUTTER NOTE:

BOX GUTTER 1:

BOX GUTTER WIDTH = 200mm

BOX GUTTER DEPTH = 75mm

RAIN WATER HEAD WIDTH = 200mm

RAIN WATER HEAD DEPTH = 125mm

RAIN WATER HEAD LENGTH = 120mm

DOWNPIPE SIZE = 100mm


BOX GUTTER 2:

BOX GUTTER WIDTH = 200mm


BOX GUTTER WIDTH = 105mm

RAIN WATER HEAD WIDTH = 200mm

RAIN WATER HEAD DEPTH = 125mm RAIN WATER HEAD LENGTH = 120mm DOWNPIPE SIZE = 100mm

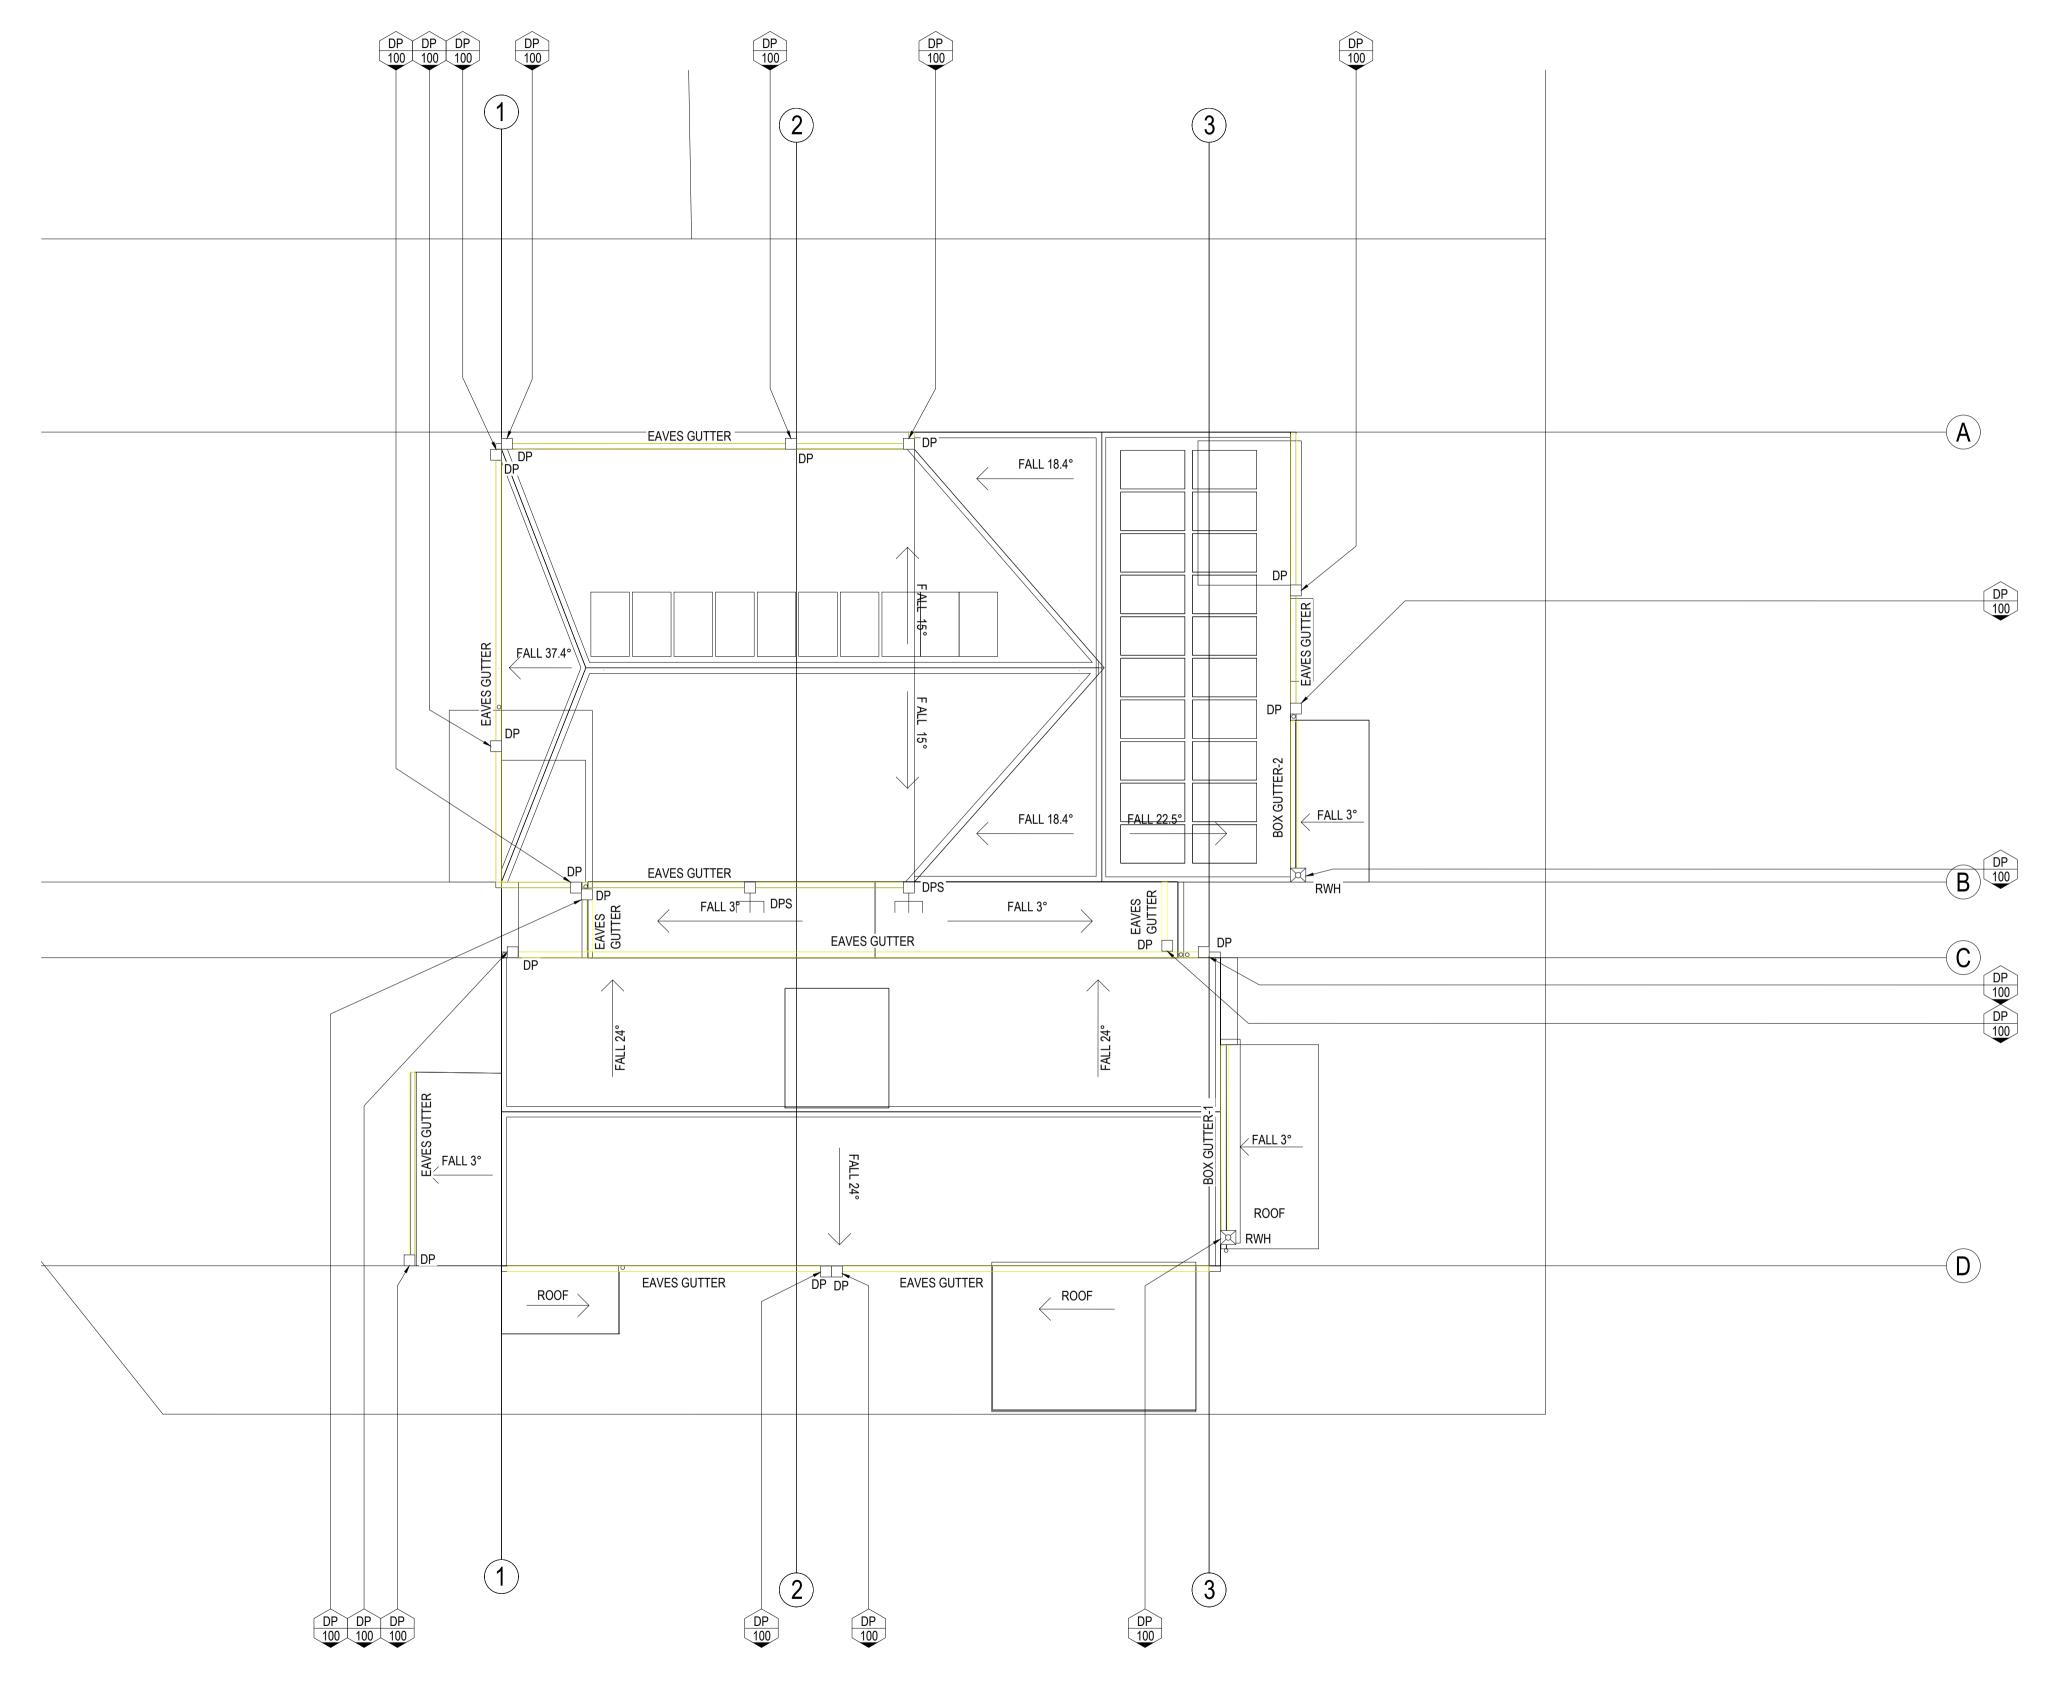


1:100 @A1 /////		1	0M15N	Л
GENERAL NOTES: 1. THE DRAWING ISSUED IS DIAGRAMMATIC, DO NOT SCALE, USE FIGURED				
DIMENSIONS ONLY. REFER TO ARCHITECTURAL DRAWINGS WHERE APPROPRIATE FOR EXACT LOCATION OF FIXTURES, DUCTS AND THE LIKE. THE DRAWING IS TO BE				
READ IN CONJUNCTION WITH ALL OTHER DOCUMENTS FORMING THE PROJECT DOCUMENTATION PACKAGE. 2. CONFIRM ALL LEVELS AND DIMENSIONS AS ACCURATE ON SITE PRIOR TO				
INSTALLATION. REPORT ALL DISCREPANCIES TO THE SUPERINTENDENT IMMEDIATELY. 3. THIS DRAWING HAS BEEN ISSUED IN CONFIDENCE AND REMAINS THE PROPERTY	2	27/02/23	REVISED PRELIMINARY-75%	
OF MCCALLUM PLUMBING & FIRE CONSULTANTS AUSTRALIA. DISTRIBUTION OR REPRODUCTION OF THE WHOLE OR PART OF THIS DRAWING WITHOUT THE	1	15/12/22	PRELIMINARY-75%	
EXPRESS PERMISSION OF MCCALLUM PLUMBING & FIRE CONSULTANTS AUSTRALIA IS A BREACH OF THE COMMONWEALTH COPYRIGHT ACT.	REV	DATE	AMENDMENT	

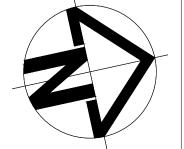









ARCHITECT: CKDS ARCHITECTURE	Drawn N.CHHETRI	PRELIMIN	IARY-75%	Size A1
CKDS ARCHITECTURE	Design B.McCALLUM	Scale 1:100	Job No. 4713-1121D	No. in Set
PROJECT: LAHC PAGEWOOD DEVELOPMENT 36-38 BIRDWOOD AVENUE, PAGEWOOD NSW ROOF DRAINAGE	Approved R.McCALLUM	DRG. No.	06	Revision 2

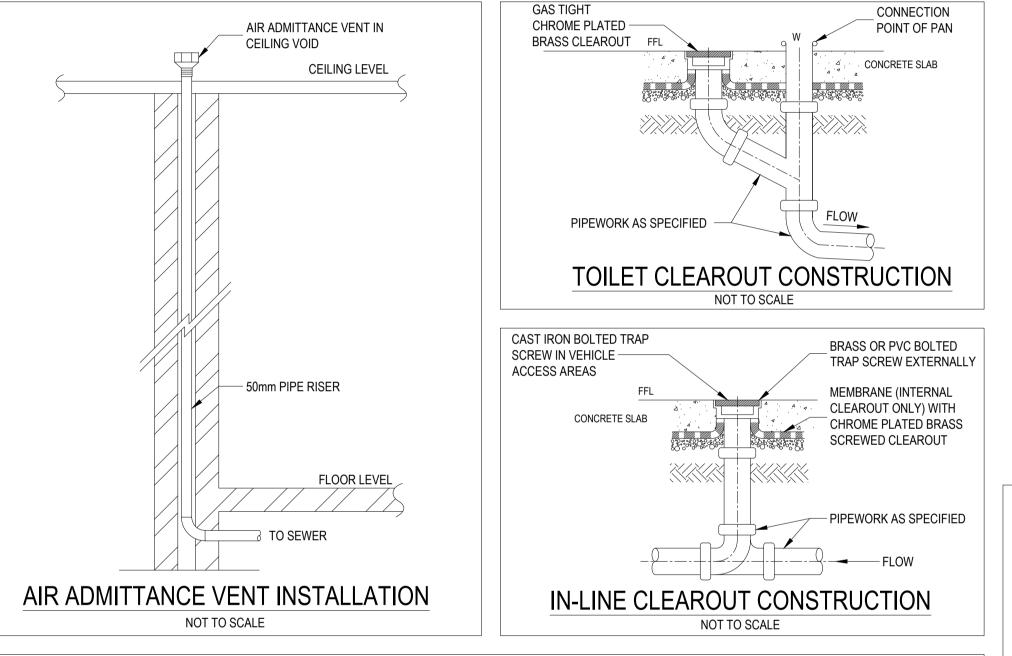


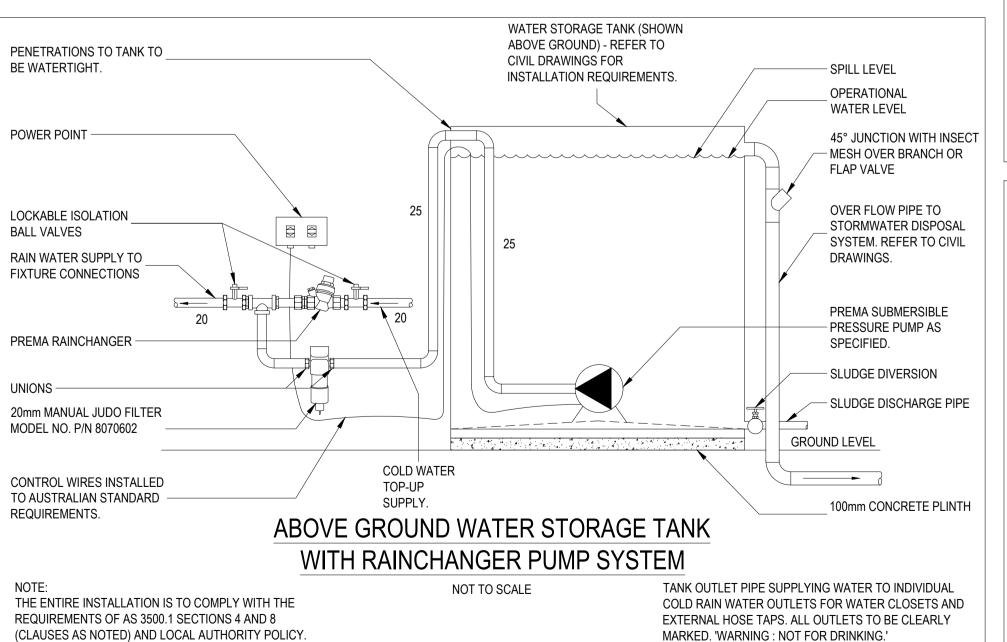


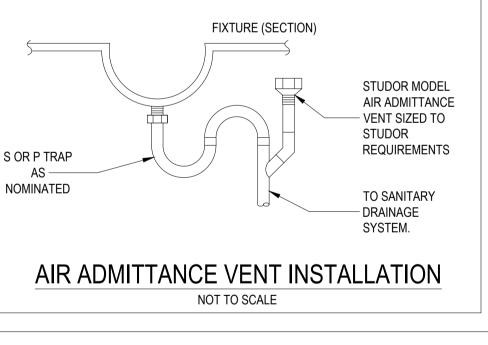

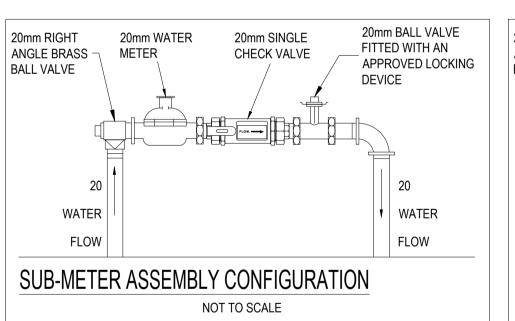

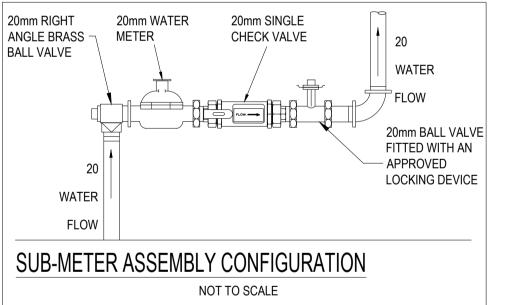

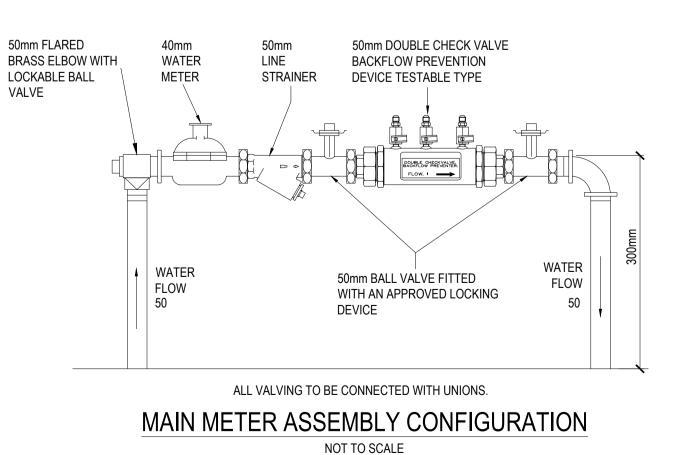

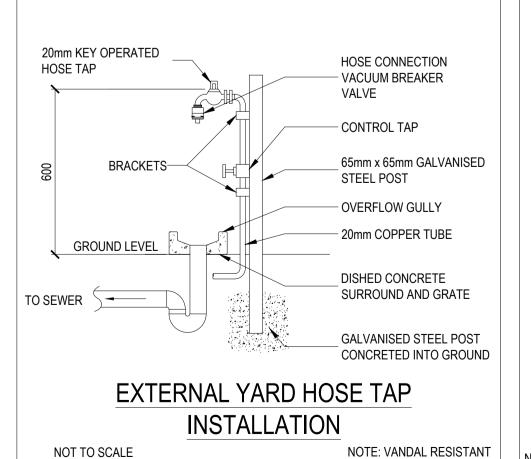

INTERNAL WALL	EXTERNAL WALL
20mm KEY OPERATED HOSE TAP	20mm COPPER TUBE BACKFLOW PREVENTION DEVICE
BRACKETS GROUND LEVEL	
	DOWN HOSE TAP
INS	TALLATION
NOT TO SCALE	NOTE: VANDAL RESISTANT

GENERAL NOTES:				
1. THE DRAWING ISSUED IS DIAGRAMMATIC. DO NOT SCALE. USE FIGURED				
DIMENSIONS ONLY. REFER TO ARCHITECTURAL DRAWINGS WHERE APPROPRIATE				
FOR EXACT LOCATION OF FIXTURES, DUCTS AND THE LIKE. THE DRAWING IS TO BE				
READ IN CONJUNCTION WITH ALL OTHER DOCUMENTS FORMING THE PROJECT				
DOCUMENTATION PACKAGE.				
2. CONFIRM ALL LEVELS AND DIMENSIONS AS ACCURATE ON SITE PRIOR TO				
INSTALLATION. REPORT ALL DISCREPANCIES TO THE SUPERINTENDENT				
IMMEDIATELY.	2	27/02/23	REVISED PRELIMINARY-75%	
3. THIS DRAWING HAS BEEN ISSUED IN CONFIDENCE AND REMAINS THE PROPERTY		21102120	TREVIOLD I TREE IIVIII VITTI 1070	
OF MCCALLUM PLUMBING & FIRE CONSULTANTS AUSTRALIA. DISTRIBUTION OR	1	15/12/22	PRELIMINARY-75%	
REPRODUCTION OF THE WHOLE OR PART OF THIS DRAWING WITHOUT THE	_ '	10/12/22	TICEINIIVACT 7070	
EXPRESS PERMISSION OF MCCALLUM PLUMBING & FIRE CONSULTANTS AUSTRALIA IS A BREACH OF THE COMMONWEALTH COPYRIGHT ACT.	REV	DATE	AMENDMENT	
AUSTRALIA IS A BREACTION THE CONTINUONWEALTH CONTRIGHT ACT.	_ V	DATE	/ NVICIADIVICIAI	





ARCHITEC	T: CKDS ARCHITECTURE	Drawn N.CHHETRI	PRELIMIN	IARY-75%	Size A1
CLIENT:	CKDS ARCHITECTURE	Design B.McCALLUM	Scale N.T.S.	Job No. 4713-1121D	No. in Set
PROJECT:	LAHC PAGEWOOD DEVELOPMENT 36-38 BIRDWOOD AVENUE, PAGEWOOD NSW	Approved R.McCALLUM	DRG. No.	07	Revision 2